



100
0 10
A1

DO NOT SCALE

File: 0119017-ATK-ZZ-02-DR-CE-090503.dwg
Date: May 13, 2026 - 7:09pm
Plotted by: ULH7849

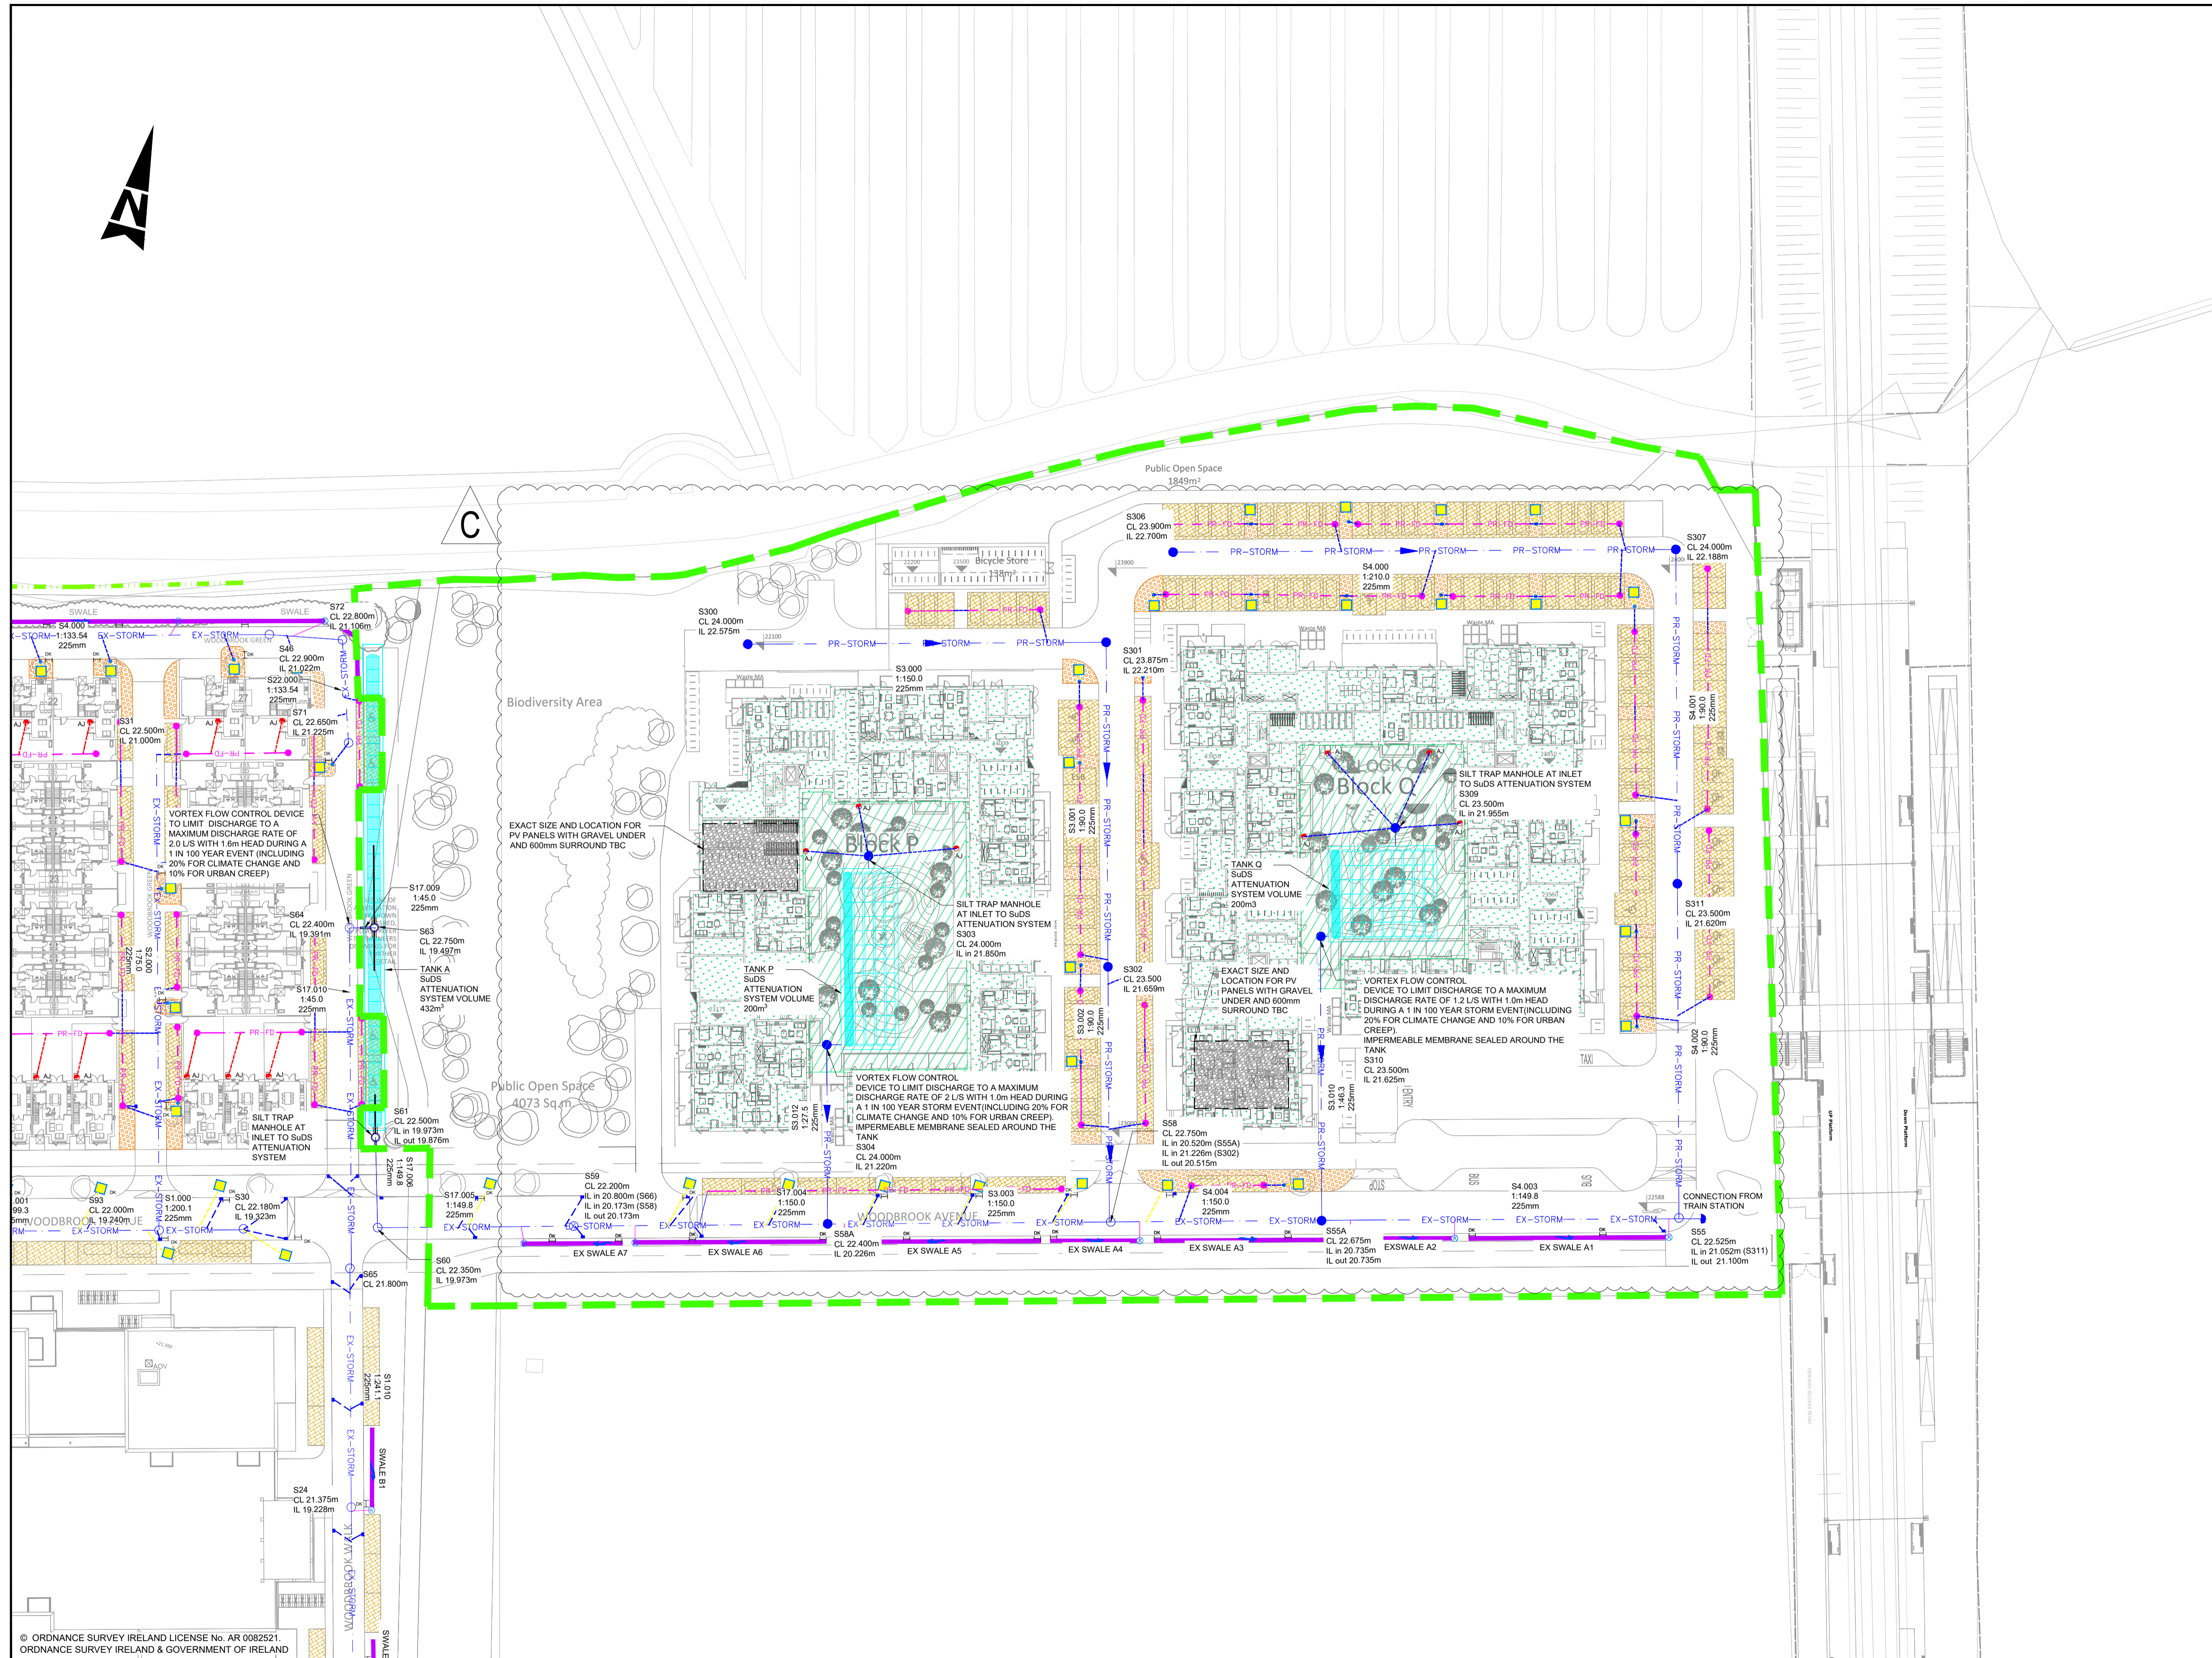

- GENERAL NOTES
1. ALL DIMENSIONS ARE IN MILLIMETRES UNLESS NOTED OTHERWISE
 2. ONLY WRITTEN DIMENSIONS SHALL BE USED. NO DIMENSIONS SHALL BE SCALED FROM THE DRAWINGS
 3. ALL LEVELS ARE IN METRES AND ARE TO MALIN HEAD DATUM
 4. ALL COORDINATES ARE IN METRES AND ARE TO IRISH TRANSVERSE MERCATOR
 5. DRAWINGS ARE TO BE READ IN CONJUNCTION WITH THE SPECIFICATION

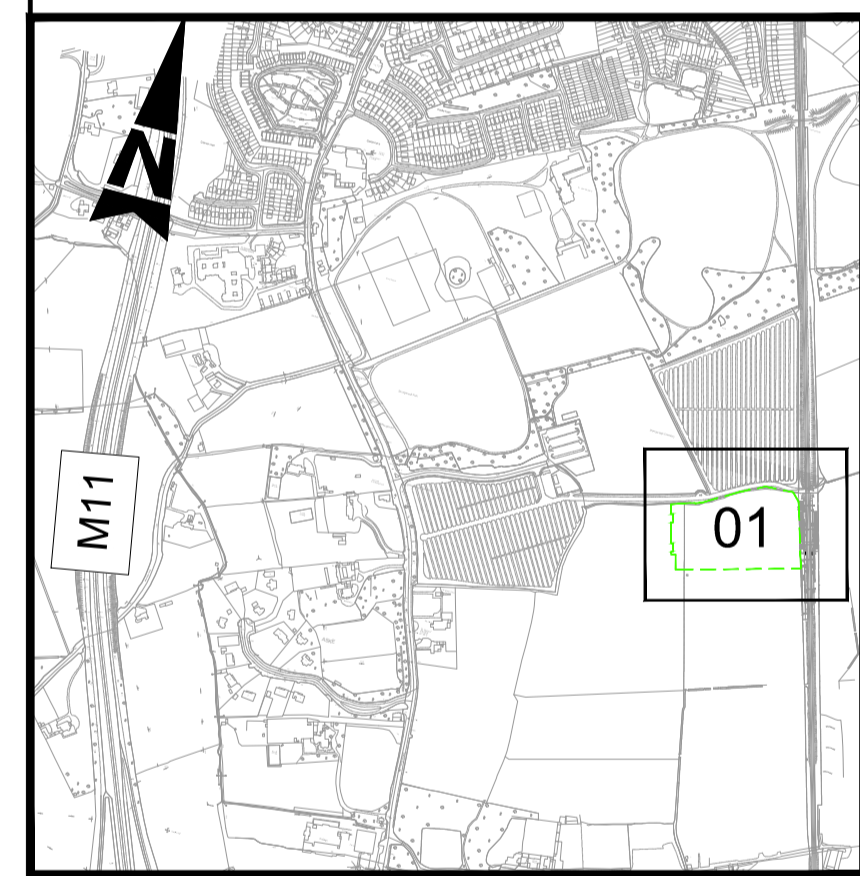

KEY PLAN
Scale NTS

- NOTE:
1. THE SURFACE WATER DRAINAGE NETWORK IS TO BE DESIGNED AND CONSTRUCTED IN COMPLIANCE WITH THE 'REGIONAL CODE OF PRACTICE FOR DRAINAGE WORKS VERSION 6.0'
 2. NO SURFACE WATER/RAINWATER TO DISCHARGE INTO THE FOUL SEWER SYSTEM UNDER ANY CIRCUMSTANCES.
 3. ALL RWP, GULLY AND CHANNEL DRAIN CONNECTIONS TO THE MAIN SURFACE WATER DRAINAGE SYSTEM ARE TO BE ACHIEVED VIA DIRECT CONNECTION TO THE MANHOLE AT LEVELS SOFFITS OR VIA SADDLE CONNECTION TO THE STORM SEWER PIPE.
 4. ALL GULLIES TO HAVE SEPARATE CONNECTIONS TO THE STORM DRAINAGE NETWORK.

PLANNING NOTES:
PLANNING PACKAGE HAS BEEN SENT FOR STAGE 1 STORMWATER AUDIT. AWAITING RESPONSE FROM AUDITOR.

Purpose FOR PLANNING

LEGEND		PROPOSED UNDERGROUND SuDS ATTENUATION SYSTEM		AREA SUBJECT TO PROPOSED DEVELOPMENT	
PR-STORM	PROPOSED STORM DRAINAGE	[Hatched Box]	PROPOSED PERMEABLE PAVING	[Green Dashed Box]	AREA SUBJECT TO PROPOSED DEVELOPMENT
SXX	PROPOSED STORM WATER MANHOLE	[Green Dotted Box]	PROPOSED EXTENSIVE GREEN ROOF	[Green Dotted Box]	EXISTING DITCH TO BE RETAINED
GY	PROPOSED ROAD GULLY	[Green Dotted Box]	PROPOSED INSPECTION CHAMBER & FILTER DRAIN (150mm)	[Green Dotted Box]	PROPOSED OVERFLOW CATCH PIT & 1500 CONNECTION TO SW MAIN
IC	PROPOSED CONNECTION FROM TREE PIT	[Green Dotted Box]	PROPOSED COLLECTOR DRAIN	[Green Dotted Box]	
PR-PT	PROPOSED PERFORATED MANHOLE COVER	[Green Dotted Box]	EXISTING STORM DRAINAGE REVIOUSLY GRANTED PERMISSION. ABP SHD PLANNING REFERENCE ABP-305844-19	[Green Dotted Box]	
[Symbol]	PROPOSED TREE PIT LOCATION	[Green Dotted Box]	EXISTING DITCH TO BE RETAINED	[Green Dotted Box]	
[Symbol]	BIO RETENTION RAIN GARDEN AND CONNECTION TO MAIN DRAINAGE	[Green Dotted Box]		[Green Dotted Box]	

Rev	Description	By	Date	Chk'd	Auth
C	FOR PLANNING	IH	13.05.26	SK	GH
B	FOR PLANNING	IH	20.02.26	SK	GH
A	FOR PLANNING	IH	09.12.25	SK	GH
-	FOR INFORMATION	IH	30.05.25	SK	GH

AtkinsRéalis

Atkins House, 150-155 Airside
Business Park, Swords, Co. Dublin
Tel: (+353) 01 810 8000
Fax: (+353) 01 810 8001

Unit 2B, 2200 Cork Airport
Business Park, Cork
Tel: (+353) 021 429 0300
Fax: (+353) 021 429 0360

2nd Floor Technology House
Parkmore Technology Park, Galway
Tel: (+353) 091 786 050
Fax: (+353) 091 779 830

Client AEVAL UNLIMITED COMPANY		Title PROPOSED STORM DRAINAGE LAYOUT	
Project WOODBROOK DART GATEWAY		Original Scale 1:500@A1 1:1000@A3	Design/Drawn IH Date 30.05.25
Status P	Drawing Number 0119017-ATK-ZZ-XX-DR-CE-090503	Checked SK Date 30.05.25	Authorised GH Date 30.05.25
Rev		Rev	
C		C	